East / West Un-Named Tributary 142" x 91" Corrugated Metal Pipe


North Rosenberger Avenue Evansville, IN

HOLEY MOLEY SAYS
"DON'T DIG
BLIND"

CALL TOLL FREE
1-800-382-5544

FOR CALLS OUTSIDE OF INDIANA TWO WORKING DAYS PLEASE LOCATION: BEDFORD, INDIANA



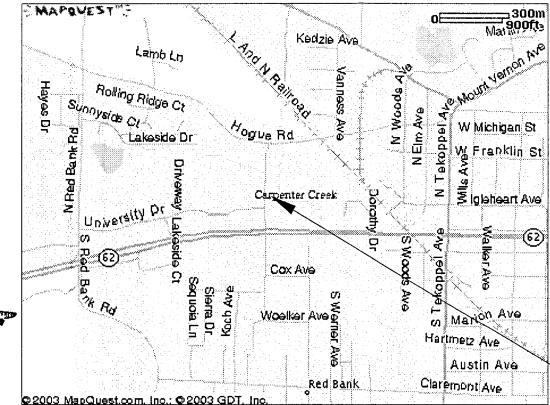

Project Location

NOTES:

- 1. SITE PLAN BY OTHERS. ELEVATIONS AND LOCATIONS SHALL BE FIELD VERIFIED PRIOR TO STARTING ANY WORK.
- 2. THE INSIDE DIAMETER OF BEND MEASURED ON THE INSIDE OF THE BAR SHALL BE 6 TIMES THE BAR DIAMETER.
- 3. ANY CHANGES IN FIELD CONDITIONS SHALL BE BROUGHT TO THE ENGINEER'S ATTENTION IMMEDIATELY.
- 4. ALL REINFORCING STEEL SHALL BE EPOXY COATED.
- 5. REINFORCING STEEL SHALL BE A MINIMUM COVER OF 2" IN ALL OTHER PARTS UNLESS NOTED OTHERWISE.
- 6. THE MINIMUM SPACING CENTER TO CENTER OF PARALLEL BARS SHALL BE $2\frac{1}{2}$ TIMES THE DIAMETER OF THE BAR. HOWEVER THE CLEAR DISTANCE BETWEEN THE BARS SHALL NOT BE LESS THAN $1\frac{1}{2}$ TIMES THE MAXIMUM SIZE OF THE COARSE AGGREGATE OR $1\frac{1}{2}$ INCHES, WHICHEVER IS GREATER.
- 7. ALL REINFORCEMENT SHALL BE TIED AT ALL INTERSECTIONS EXCEPT WHERE SPACING IS LESS THAN 1 FOOT IN EACH DIRECTION, IN WHICH CASE ALTERNATE INTERSECTIONS SHALL BE TIED.
- 8. UNLESS OTHERWISE NOTED, SPLICES IN ADJACENT LINES OF REINFORCING BARS SHALL BE STAGGERED. THE MINIMUM DISTANCE BETWEEN STAGGERED SPLICES FOR REINFORCING BARS SHALL BE THE LENGTH REQUIRED FOR A LAPPED SPLICE IN THE BAR.
- 9. THE ENGINEER SHALL BE NOTIFIED 48 HOURS PRIOR TO STARTING ALL CONSTRUCTION OPERATIONS. 10. ALL DIMENSIONS SHALL BE FIELD VERIFIED.
- 11. ALL REBAR SHALL BE CHECKED FOR THE ACCURACY OF DIMENSIONS AND PLACEMENT PRIOR TO ORDERING,
- 12. ALL STANDARD CONSTRUCTIONS PRACTICES SHALL BE FOLLOWED.
- 13. ALL APPLICABLE NATIONAL, STATE AND LOCAL CODES AND REGULATIONS SHALL BE FOLLOWED.

Jeer Loca	don
	DRAWING INDEX
SHEET	SHEET TITLE
0	COVER SHEET
P1	WEST PIPE STRUCTURE PLAN
P2	END WALLS 200 & 202
P3	END WALLS 200 & 202 DETAILS
P4	END WALL 204
P5	END WALL 204 DETAILS

RECEIVED BY THE
RECEIVED BY THE
VANDERBURGH COUNT
VANDERBURGH OFFICE
SURVEYOR'S 0FFICE
2 / 1-14-05


CARPENTIER CREEK C.M. PIPE

> 826 West County Road 175 South French Lick, IN 47432 812-639-0351

B TARR & ASSOCIATES




COVER SHEET 2 APRIL 2005 SHEET 0

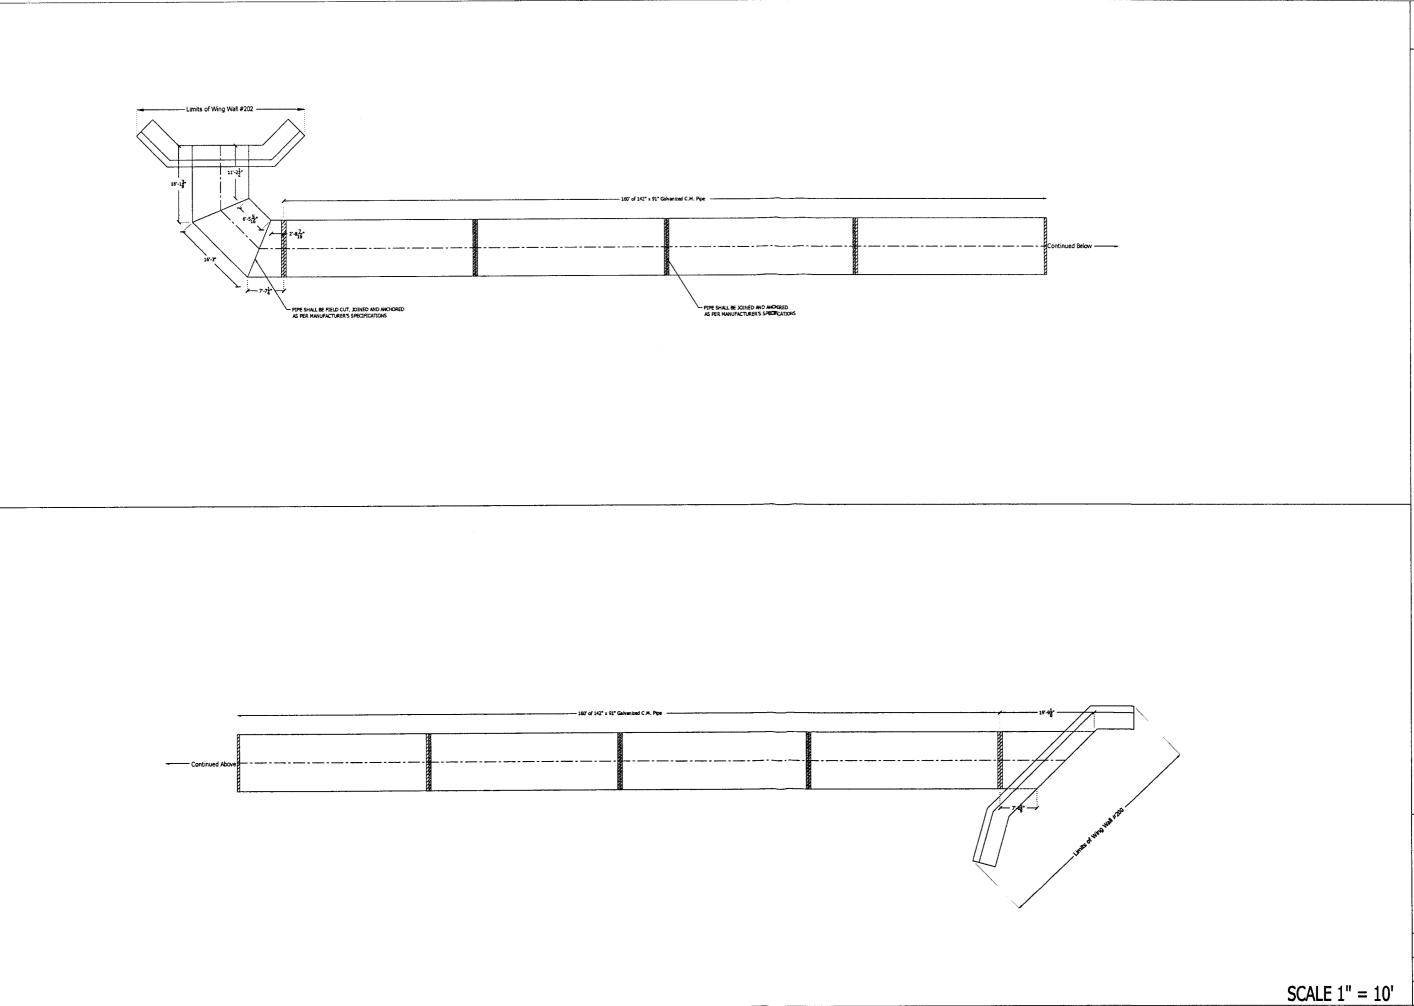


CARPENTIER CREEK
CMP PIPE

131 The Woods Bedford, IN 47421 812-275-7577 dbtarr@insiqhtbb.cor

B TARRA

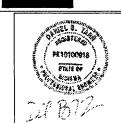


PIPE PLAN 2 APRIL 2005 SHEET P1

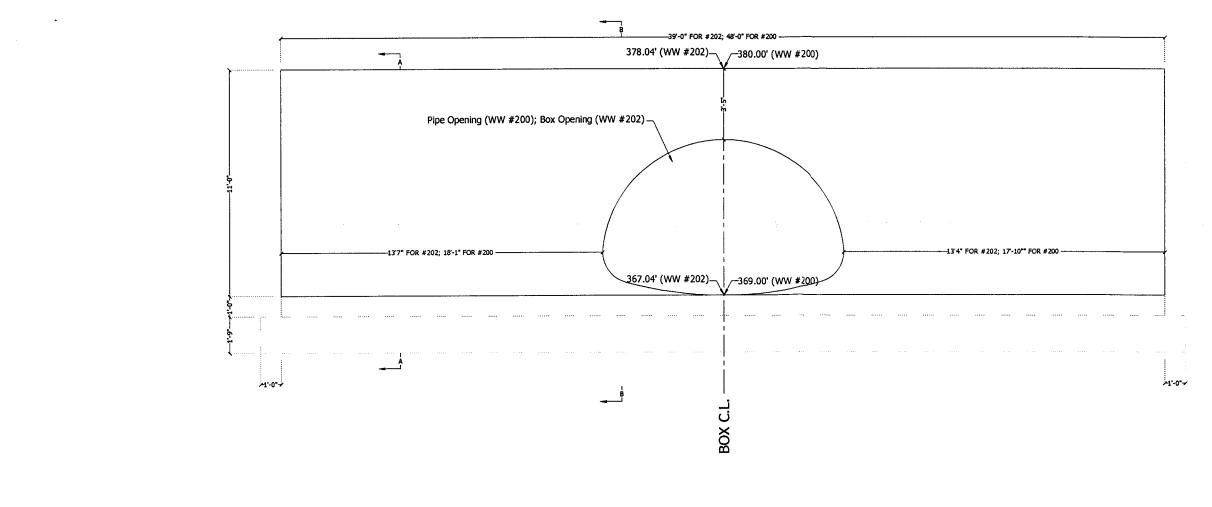

SECTION A-A




CARPENTIER CREEK
CMP PIPE

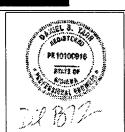

WALL 200 & 202

2 APRIL 2005

SHEET P2

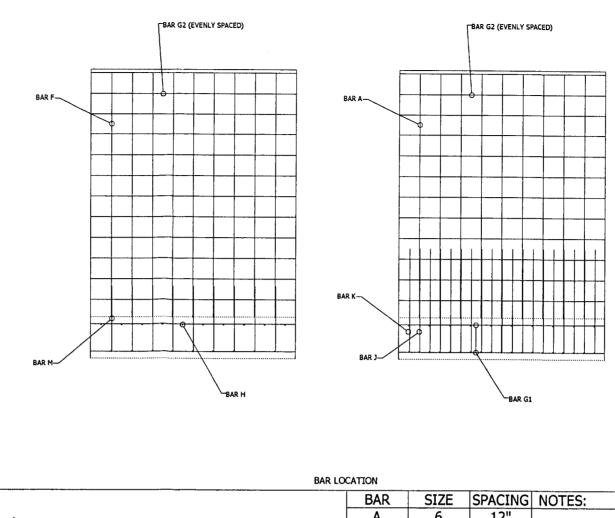

BAR A (PAIRED W/ J) BAR F-BACK FACE SLOPE = 1:12 BAR M (PAIRED W/ BAR F)

BAR LOCATIONS

	DAK SIZE
A	A 6
F	F 6
G1	G1 6
G2	G2 6
G3	G3 6
Н	Н 6
J	J 6
K	K 6

BENDING DIAGRAM BAR M

Α	6	12"	
F	6	12"	
G1	6	12"	
G2	6	12"	
G3	6	12"	
Н	6	12"	
J	6	12"	SEE BENDING DETAIL
K	6	12"	SEE BENDING DETAIL
M	6	12"	SEE BENDING DETAIL
7			

- NOTES:


 1. ALL CONCRETE SHALL BE 4000 PSI 28 DAY COMPRESSIVE STRENGTH

 2. ALL STEEL SHALL CONFORM TO ASTM A615 GRADE 60.


 3. ALL APPLICABLE CODES AND REGULATIONS SHALL BE FOLLOWED.

 4. ALL CURRENT OSHA & IOSHA SAFETY PRECAUTIONS SHALL BE FOLLOWED.

 5. STEM OFFSET (IN.) SHALL BE EQUAL TO THE HEIGTH (FT.) DIVIDED BY 16.

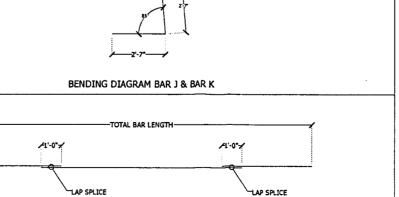


LAP SPLICE DETAIL

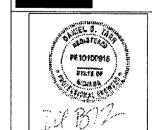


CARPENTIER CREEK CMP PIPE

DETAILS 200 & 202 2 APRIL 2005 SHEET P3

SCALE 1" = 5'

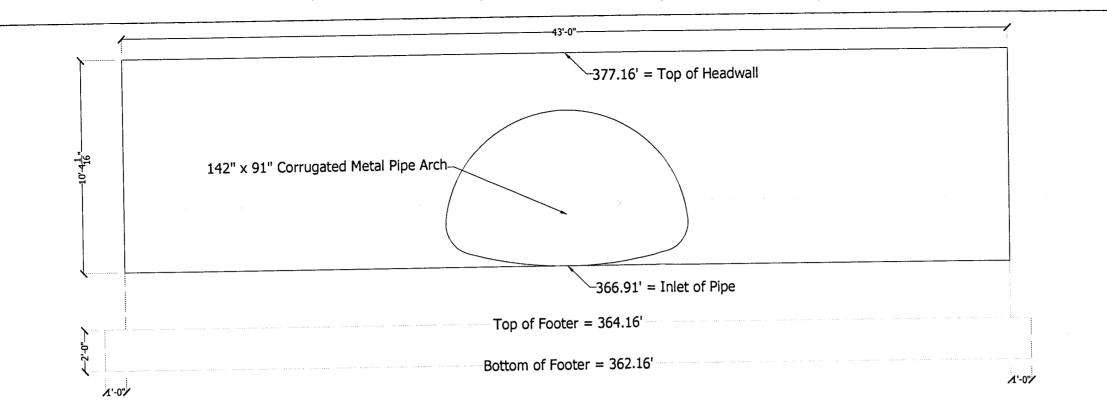

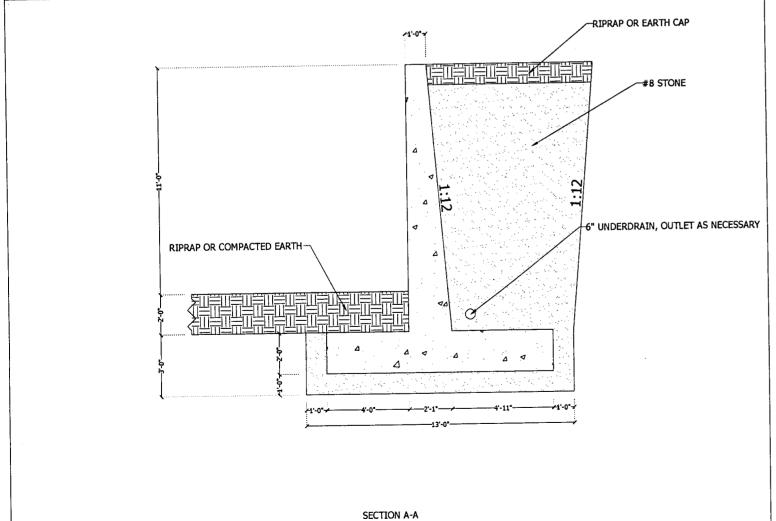


NOTES:

- 1. ALL MEASUREMENTS SHALL BE FIELD VERIFIED.
- 2. THE PIPE SHALL BE SET ON A 15 DEGREE SKEW.

CARPENTIER CREEK
CMP PIPE

131 The Woods Bedford, IN 47421 812-275-7577


OB TARR & ASSOCIATE

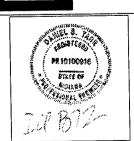

WALL 204

2 APRIL 2005


SHEET P4

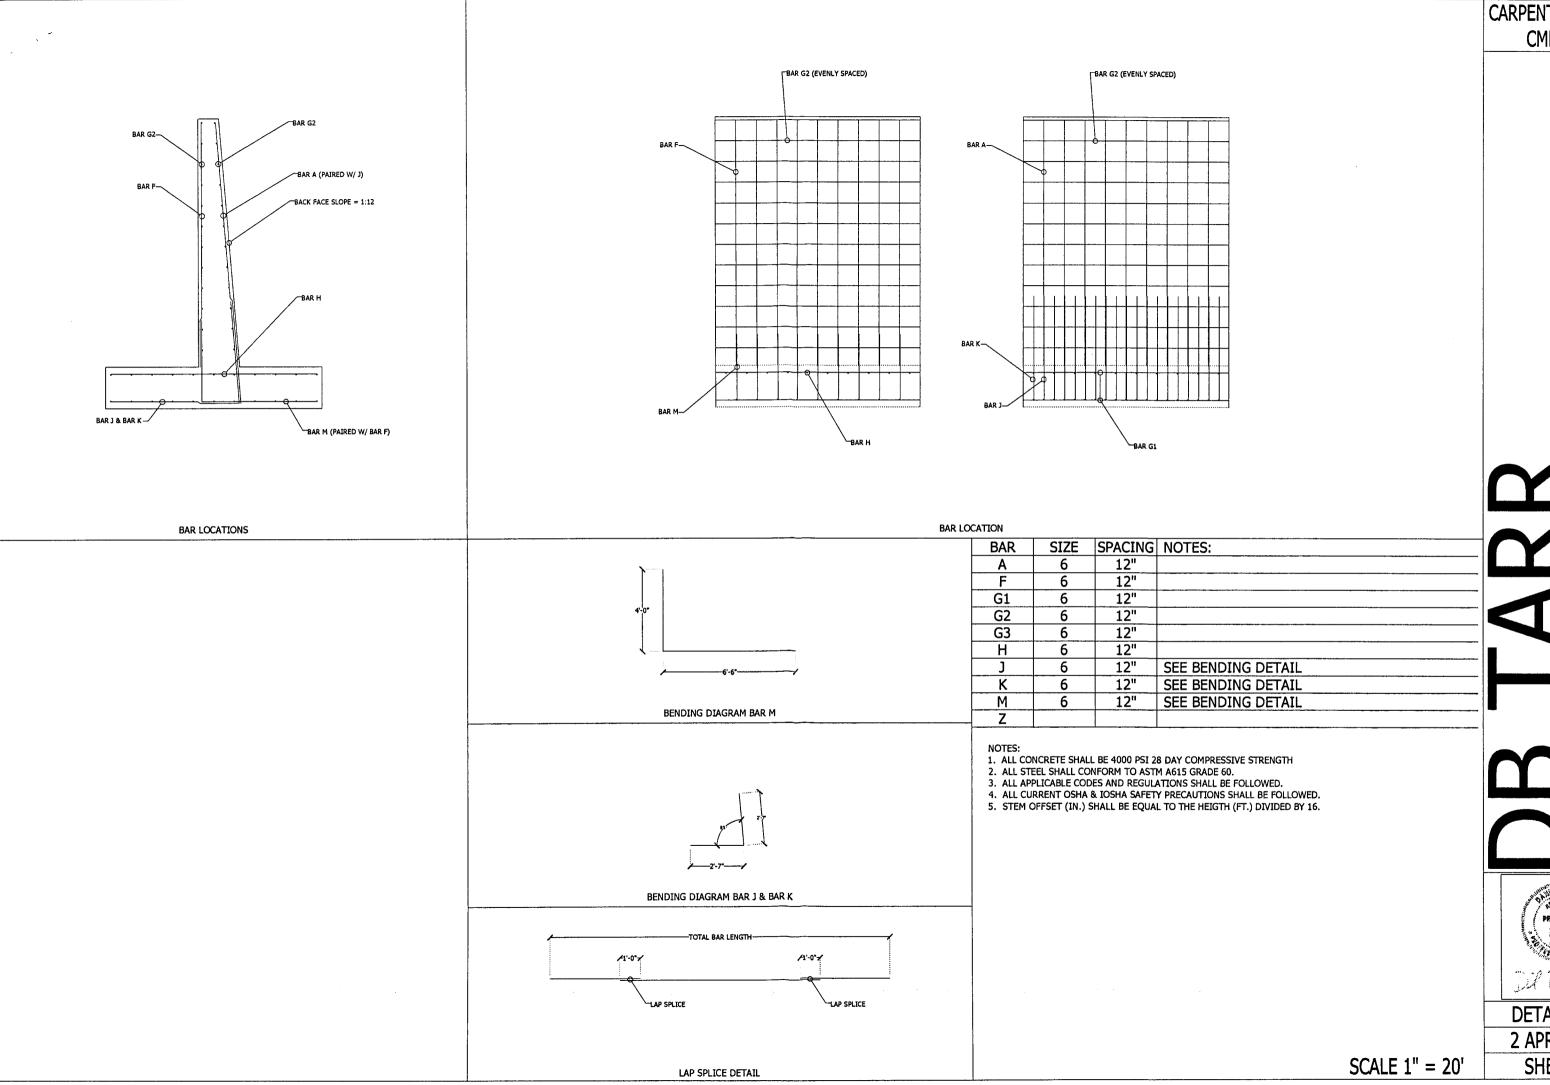

CARPENTIER CREEK
CMP PIPE

131 The Woods Bedford, IN 47421 812-275-7577

AKK SSOCIATE

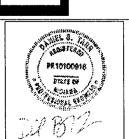

DETAILS 208 2 APRIL 2005 SHEET P5