CAMBRIDGE SECTION TWO RESIDENTIAL SUBDIVISION RECORD DRAWINGS

APPROVALS

SANITARY SEWER PLANS

RECOMMENDED BY: TRAVIS HILDEBRANDT, DIRECTOR ENGINEERING SERVICES , DATE: _______

APPROVED BY: EVANSVILLE WATER AND SEWER UTILITY BOARD _____, DATE: ______

DRAINAGE PLANS

RECOMMENDED BY:

Bill Jeffers, Vanderburgh County Surveyor

VANDERBURGH COUNTY DRAINAGE BOARD

APPROVED BY:

Troy Tornatta


APPROVED BY:

Bill Nix

DATE:

D

ROADWAY PLANS

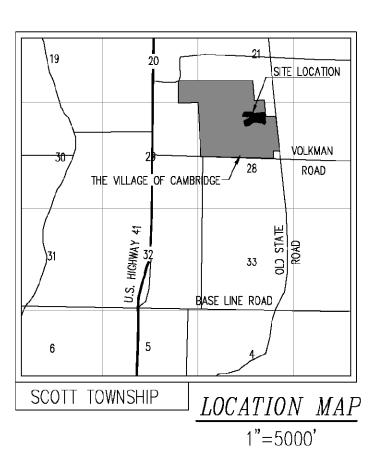


Engineers-Surveyors

10335 Hedden Road, Suite 2
Evansville, Indiana 47725
(812) 868-0877

SHEET INDEX

COVER SHEET	
PLAT	PLAT
INDEX	INDEX
DRAINAGE PLAN	DR-1
WATERLINE EXTENSION PLAN	WE-1
PLAN & PROFILE-LONGMEADOW WAY	RP-1
PLAN & PROFILE-HAVERHILL DRIVE	RP-2
STORM WATER POLLUTION PREVENTION PLAN	SWP3
SANITARY DETAILS	DE-1
PAVEMENT, ENTRANCE, & INTERSECTION DETAILS	DE-2
STORM SEWER DETAILS	DE-3



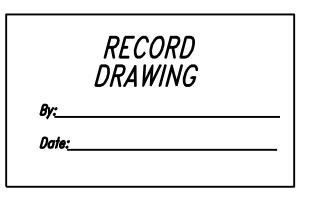

NOTIFICATION REQUIREMENTS

THE CONTRACTORS SHALL NOTIFY ALL UTILITIES 48 HOURS BEFORE BEGINNING WORK FOR FIELD LOCATIONS. THE UTILITIES TO BE NOTIFIED INCLUDE THE FOLLOWING:

VECTREN

EVANSVILLE WATER & SEWER UTILITY

SBC


TCI OF EVANSVILLE


1-800-382-5544


THE FOLLOWING GOVERNMENTAL AGENCIES SHALL BE NOTIFIED 24 HOURS PRIOR TO BEGINNING WORK AND ON A DAILY BASIS THEREAFTER WHEN PERFORMING THE WORK LISTED BELOW:

STORM SEWERS, STREET SUBGRADE,& STREETS
VANDERBURGH COUNTY ENGINEER 435-5773

EVANSVILLE WATER & SEWER UTILITY OPERATIONS DEPT. 421-2130

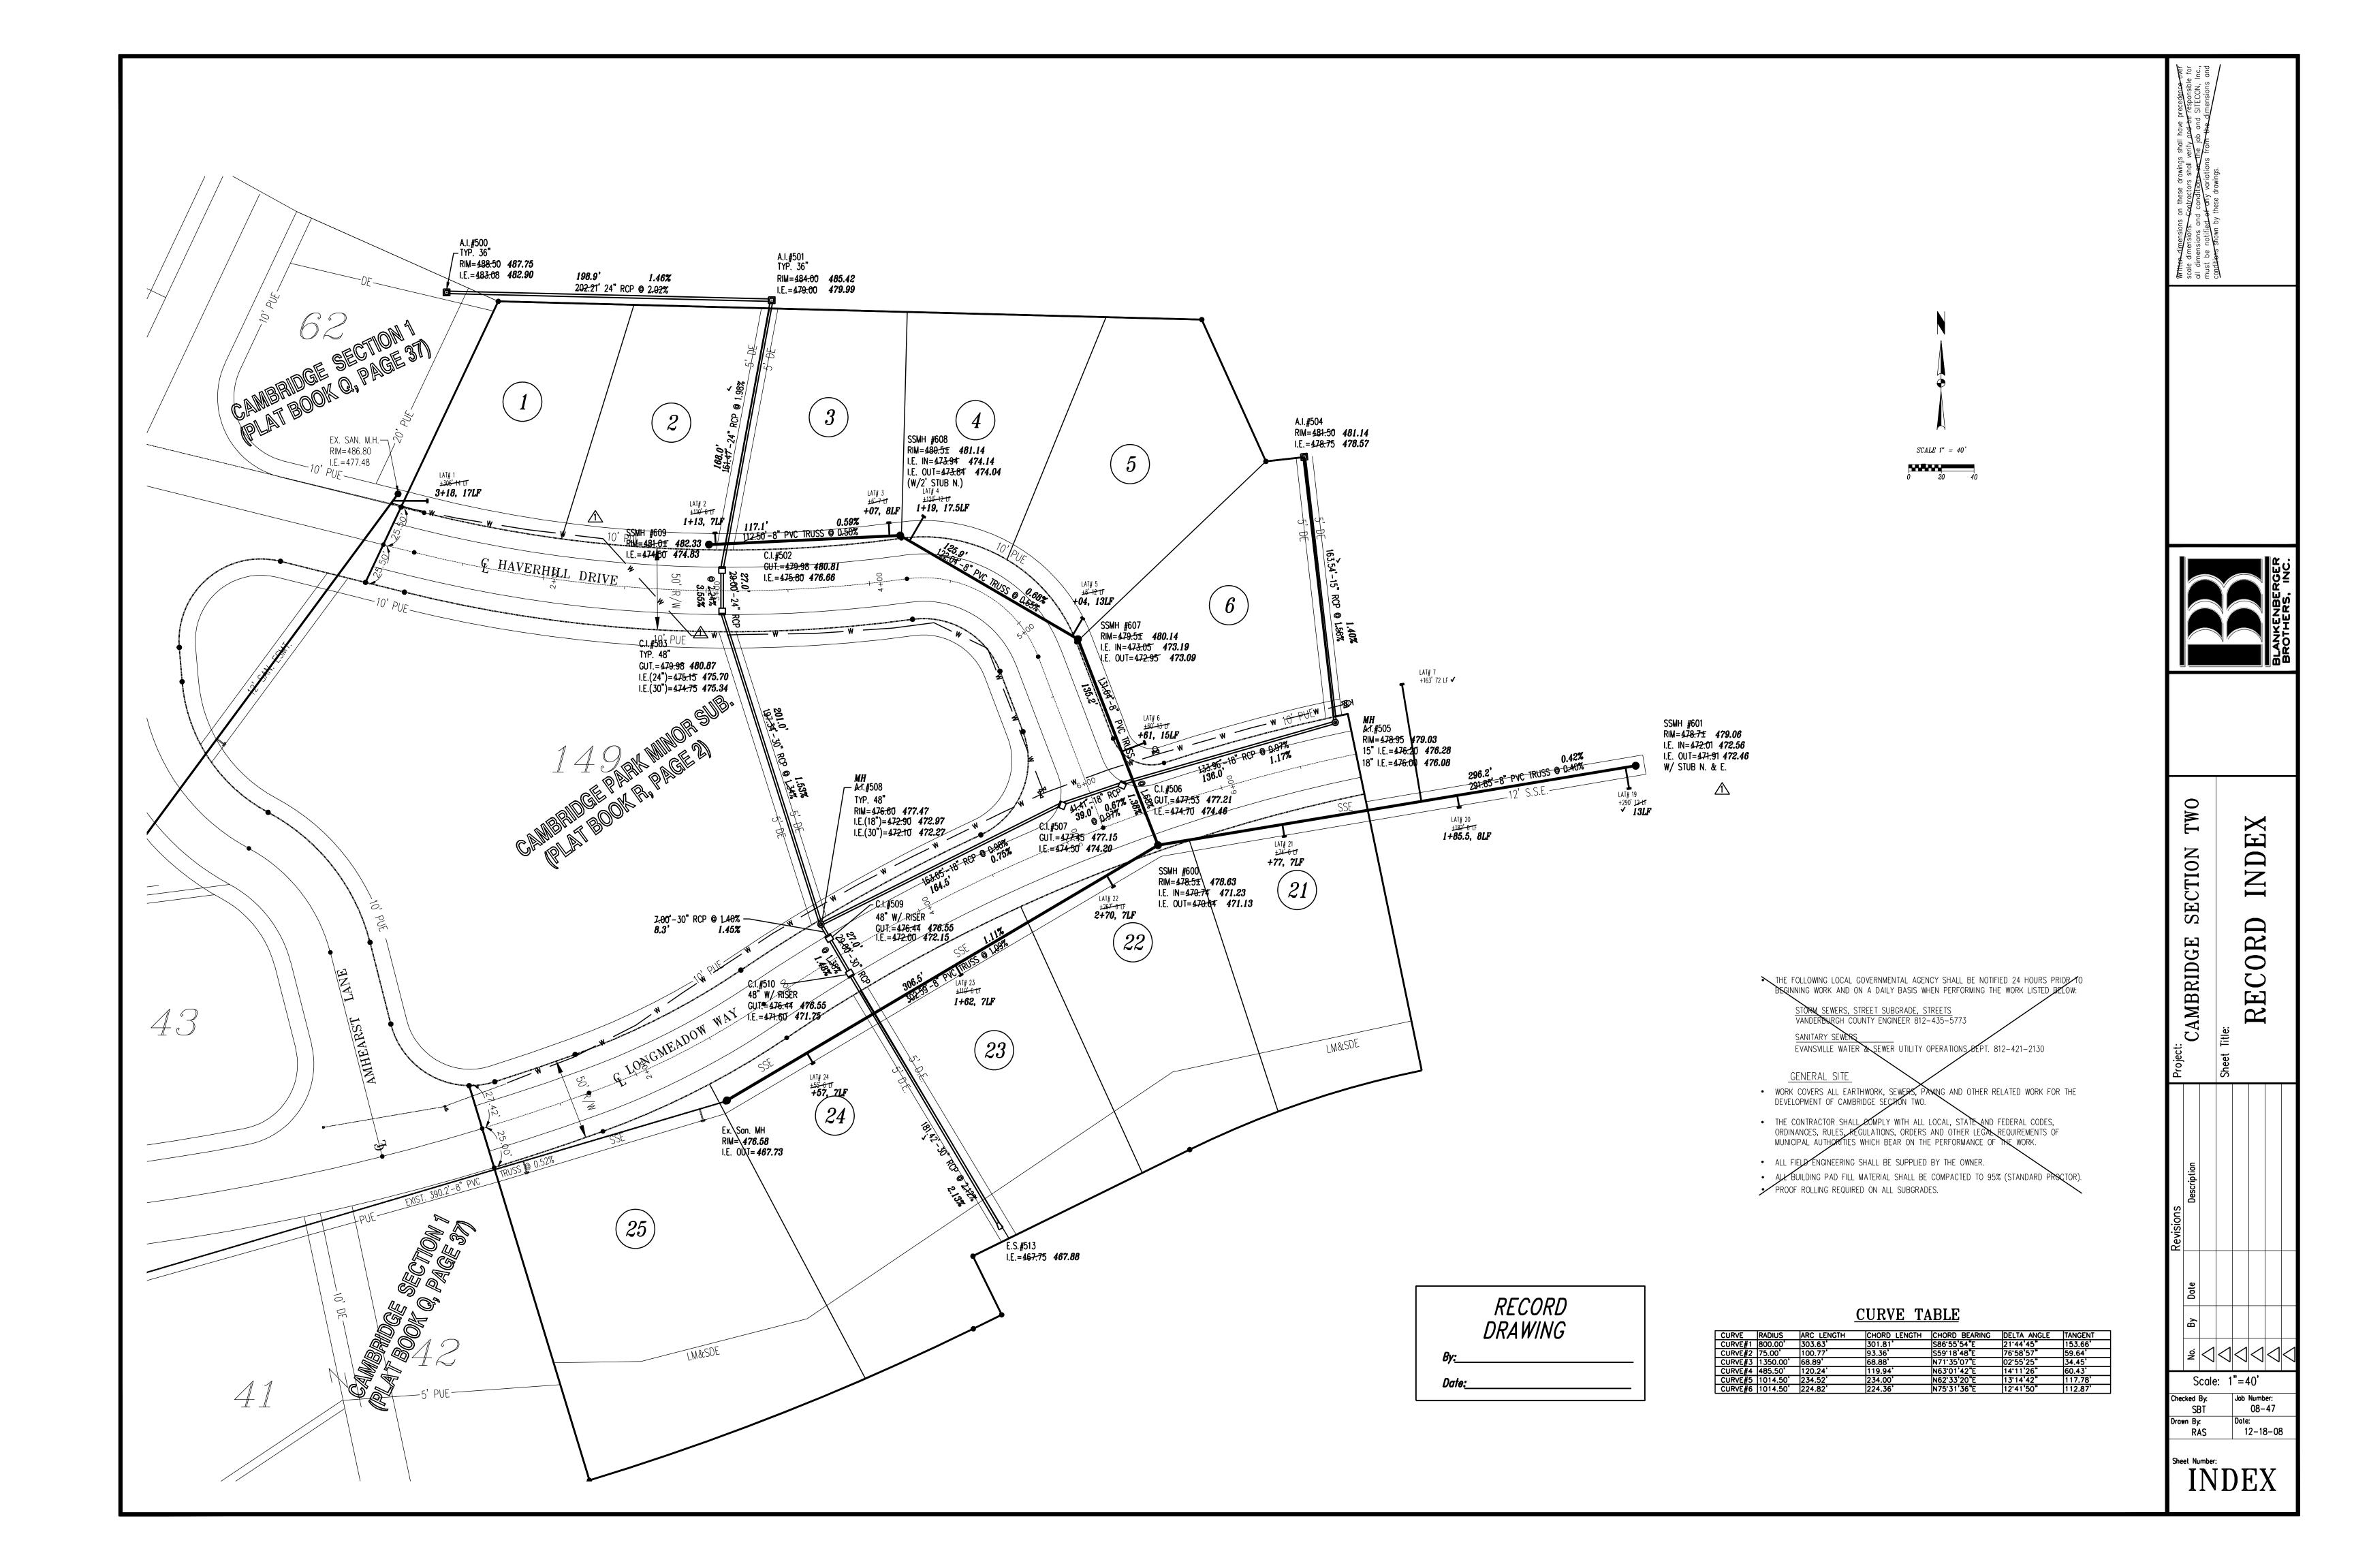

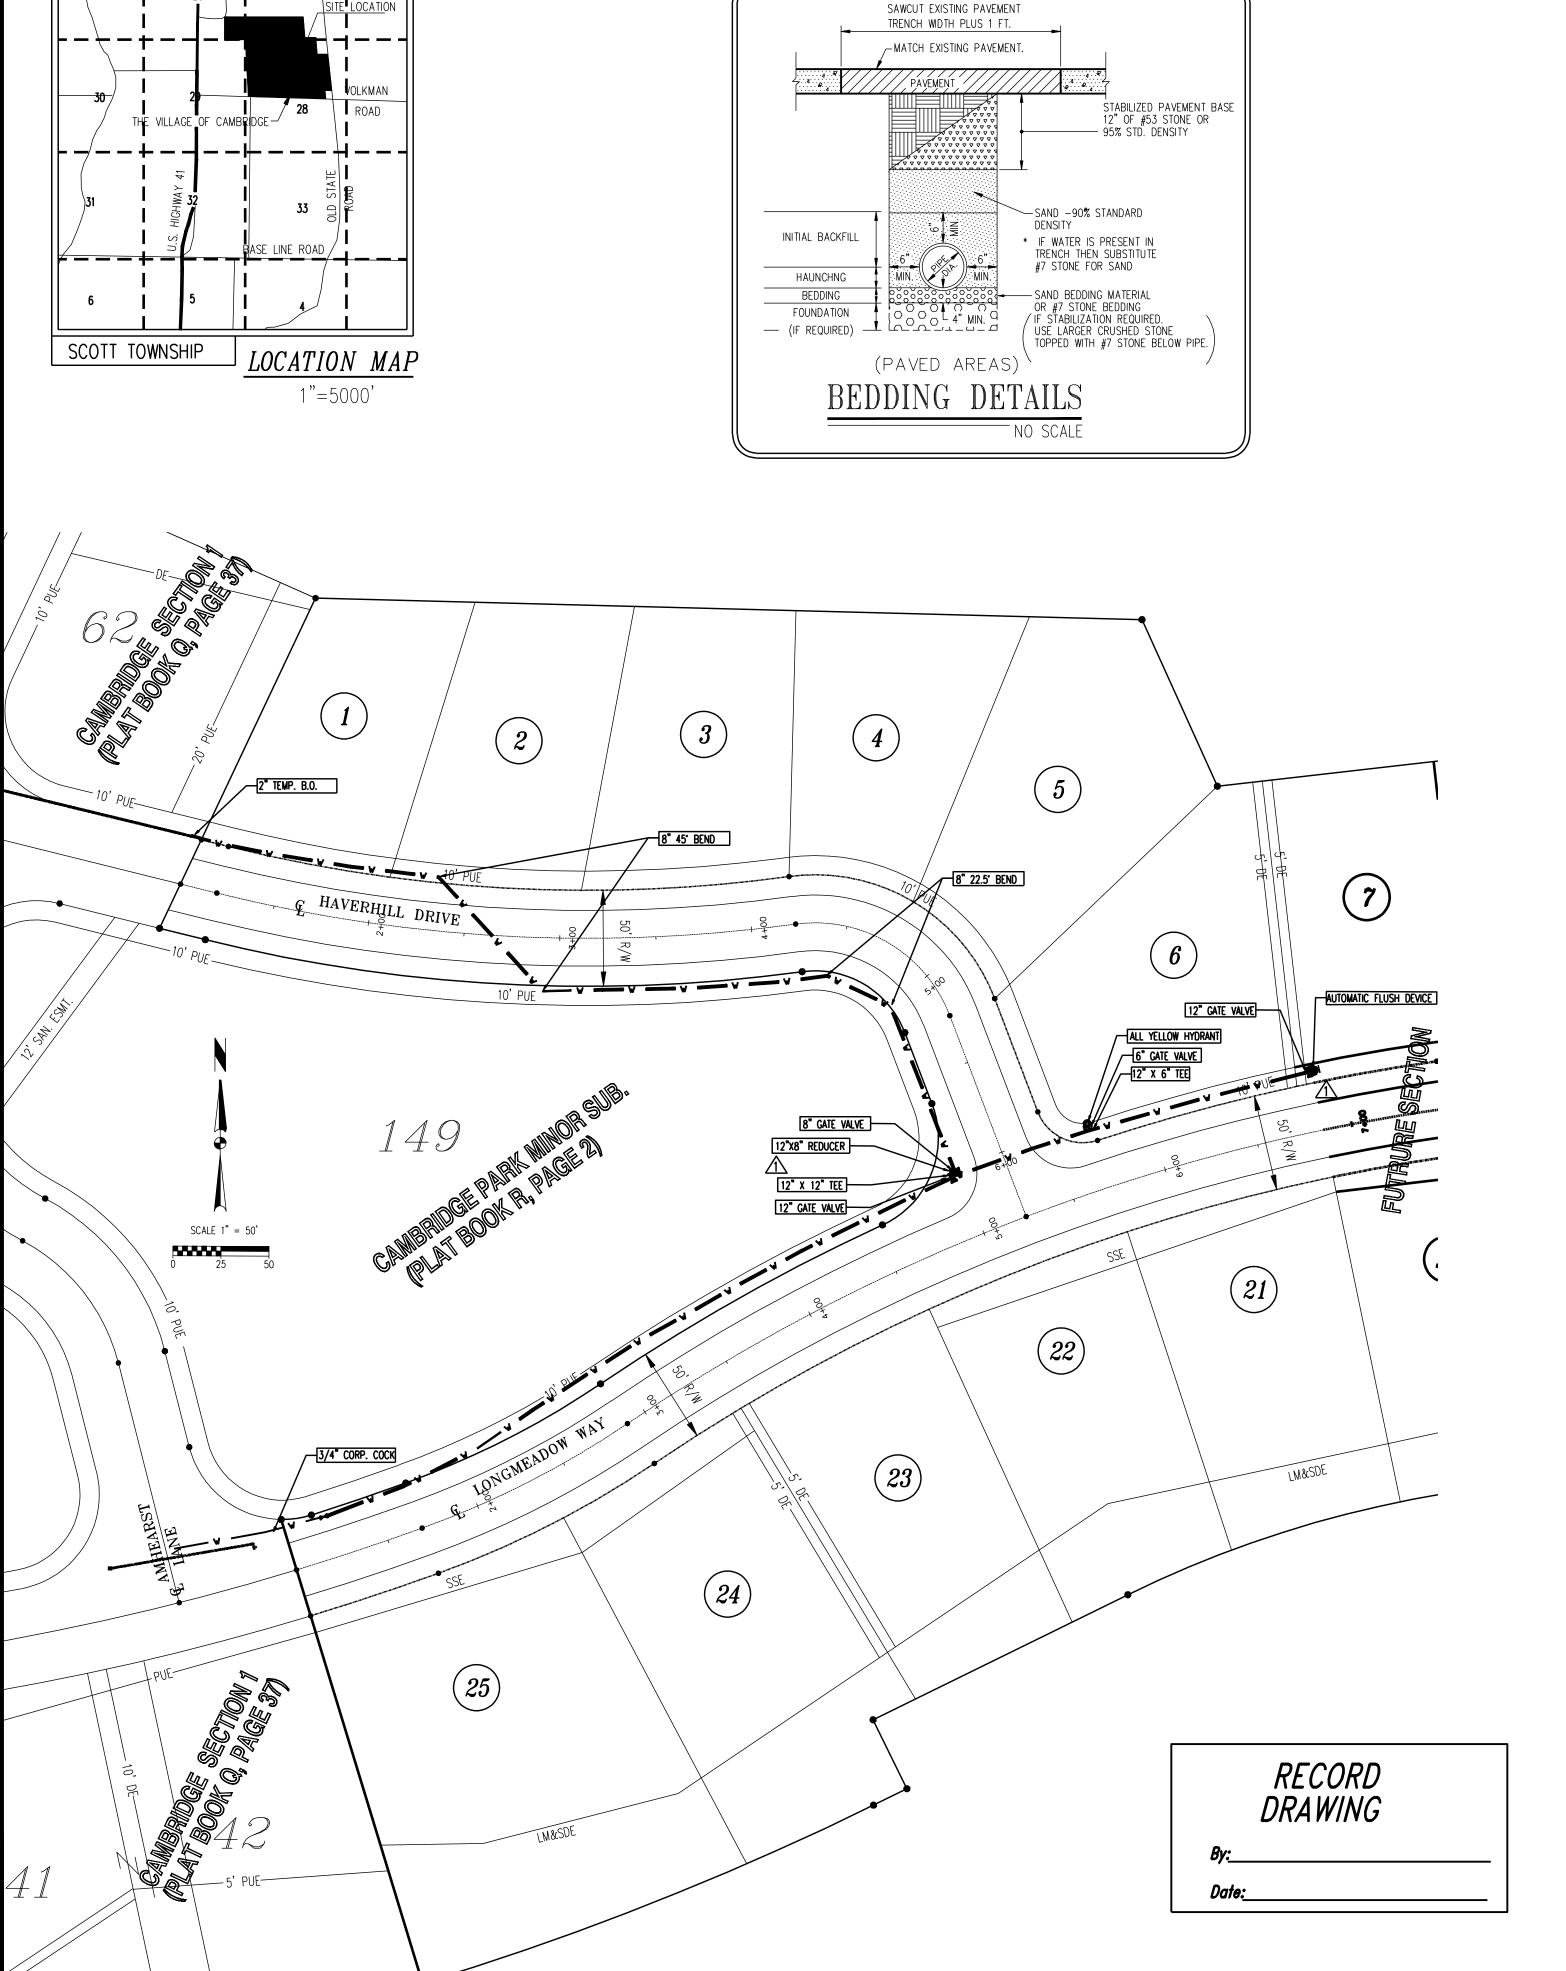

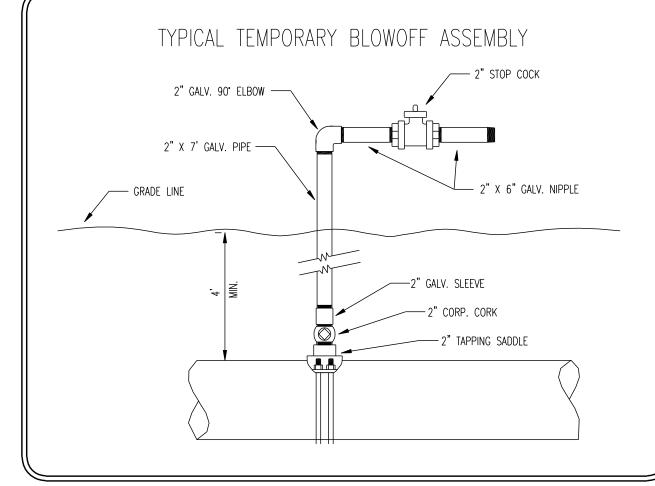

TYPICAL HYDRANT ASSEMBLY - HYDRANT WIRE TO BE SLEEVED BETWEEN VALVE BOX HALVES APPROX. 3' ABOVE GRADE -GATE VALVE & BOX - GRADE LINE TRACING WIRE 8"CONC. BLOCK - FULLY RESTRAIN ALL JOINTS BETWEEN HYDRANT AND MAIN USE D.I. PIPE OR ANCHOR COUPLING FIELDBED ROCK-

TYPICAL TRACING WIRE DETAIL

- GRADE LINE

TAPE TRACING WIRE TO TOP _

OF MAIN UNTIL BACKFILLED

WIRE TO BE SLEEVED BETWEEN VALVE TO BOX HALVES EXTEND APPROXIMATELY

3' ABOVE GRADE

SERVICE TAP -

-STANDARD VALVE BOX SET TO GRADE



597' 12" C-900 PVC PLASTIC PIPE 8" C-900 PVC PLASTIC PIPE 12" GATE VALVE VALVE BOXES 8" GATE VALVE 6" GATE VALVE ALL YELLOW HYDRANT

TEMPORARY BLOW OFF ASSEMBLY 12" 22.5' BENDS 12" 45' BENDS 3/4" CORP. COCKS AUTOMATIC FLUSH DEVICE

AND BLOWOFF THROUGH BLOW OFF ASSEMBLY AT ② & ③.

CHLORINATION NOTE

CHLORINATE THROUGH 3/4" CORP. COCK @ 1

WATER LINE RECORD LOCATION STORM SEWER SANITARY SEWER

GENERAL NOTES

1. PVC PIPE MAY BE BENT NO MORE THAN 12.3 INCHES OVER A 20' JOINT. USE FITTINGS AS NECESSARY TO PREVENT OVER-DEFLECTION OF PIPE.

2. ALL RESTRAINED JOINTS PER EVANSVILLE WATER SEWER UTILITY SPECIFICATIONS.

3. ALL BLOW OFF ASSEMBLIES SHALL HAVE PIPE JOINTS, PRIOR TO BLOW OFF, RESTRAINED WITH SERIES 1500 RESTRAINERS, IN ACCORDANCE WITH THE JOINT RESTRAINT MANUFACTURERS SPECIFICATIONS.

4. ALL FIRE HYDRANTS TO BE LOCATED SO THAT THEY DO NOT INTERFERE WITH THE SIDEWALKS, (WHERE REQUIRED).

5. CONTRACTOR SHALL COMPLY WITH ALL LOCAL, STATE AND FEDERAL CODES, ORDINANCES, RULES, REGULATIONS, ORDERS AND OTHER LEGAL REQUIREMENTS OF MUNICIPAL AUTHORITIES WHICH BEAR ON THE PERFORMANCE OF THE WORK.

6. THE CONTRACTOR IS CAUTIONED THAT THE LOCATION AND / OR ELEVATION OF EXISTING UTILITIES AS SHOWN ON THESE PLANS IS BASED ON RECORDS OF VARIOUS UTILITY COMPANIES, AND WHERE POSSIBLE MEASUREMENTS TAKEN IN THE FIELD. THE INFORMATION IS NOT TO BE RELIED ON AS BEING EXACT OR COMPLETE. THE CONTRACTOR MUST CONTACT THE APPROPRIATE UTILITY COMPANY AT LEAST 48 HOURS BEFORE ANY EXCAVATION TO REQUEST EXACT FIELD LOCATION OF UTILITIES. CONTRACTOR SHALL LOCATE EXISTING UTILITIES AND ESTABLISH ELEVATIONS AND CLEARANCES WITH PROPOSED IMPROVEMENTS PRIOR TO INITIATING CONSTRUCTION. INDIANA UNDERGROUND UTILITY LOCATE SERVICE (I.U.P.P.S.)

PHONE: 1-(800)-382-55447. MATERIAL SPECIFICATIONS SHALL BE IN CONFORMANCE WITH APPLICABLE PORTIONS OF THE INDOT STANDARD SPECIFICATIONS.

(LATEST EDITION) UNLESS SPECIFICALLY STATED OTHERWISE ON THESE


8. MINIMUM OF 18 INCH VERTICAL AND 10 FEET HORIZONTAL CLEARANCE TO BE MAINTAINED BETWEEN WATERLINES AND SEWERS.


9. REMOVE ALL 2" TEMPORARY BLOW OFFS AND REPLACE 2" CORP COCK WITH PLUG PRIOR TO FINAL ACTIVATION.


10. ALL SHORT NIPPLES (16" OR LESS) BETWEEN FITTINGS AND VALVES TO BE ANCHOR COUPLING OR DUCTILE IRON PIPE.

11. MINIMUM DEPTH FOR WATERMAINS IS FOUR FEET.

PLANS, CONTRACT DOCUMENTS, OR LOCAL CODE.

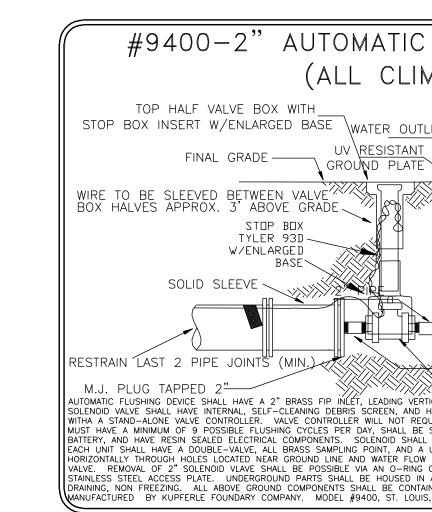

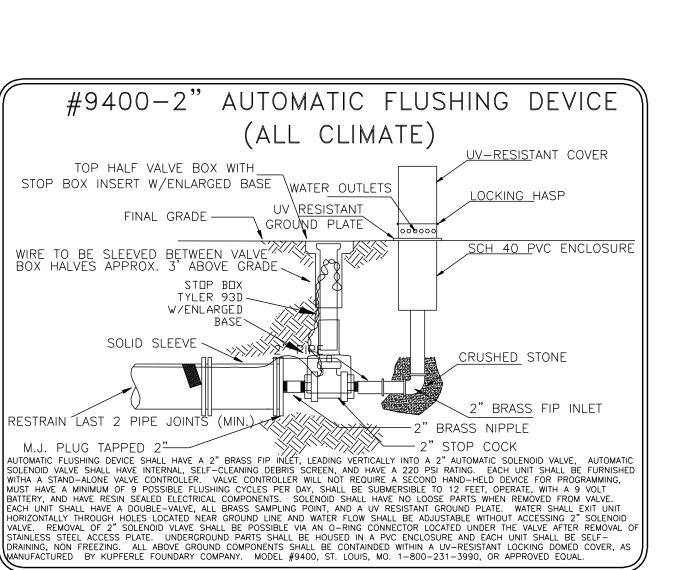

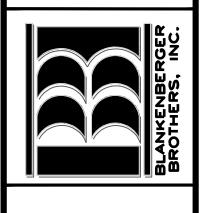

EXTEN: DRAWIN SECTION WATERLINE RECORD CAMBRIDGE

Z

Scale: 1"=50' Checked By: Job Number: 08-47 SBT Drawn By:

12-01-08

WE-1

RAS

Sheet Number:

THE FOLLOWING LOCAL GOVERNMENTAL AGENCY SHALL BE NOTIFIED 24 HOURS PRIOR TO BEGINNING WORK AND ON A DAILY BASIS WHEN PERFORMING THE WORK LISTED BELOW:

STORM SEWERS, STREET SUBGRADE, STREETS
VANDERBURGH COUNTY ENGINEER 812-435-5773


SANITARY SEWERS
EVANSVILLE WATER & SEWER UTILITY OPERATIONS DEPT. 812-421-2130


GENERAL SITE

- WORK COVERS ALL EARTHWORK, SEWERS, PAYING AND OTHER RELATED WORK FOR THE DEVELOPMENT OF CAMBRIDGE SECTION TWO.
- THE CONTRACTOR SHALL COMPLY WITH ALL LOCAL, STATE AND FEDERAL CODES, ORDINANCES, RULES, REGULATIONS, ORDERS AND OTHER LEGAL REQUIREMENTS OF MUNICIPAL AUTHORITIES WHICH BEAR ON THE PERFORMANCE OF THE WORK.
- ALL FIELD ENGINEERING SHALL BE SUPPLIED BY THE OWNER.
- ALL BUILDING PAD FILL MATERIAL SHALL BE COMPACTED TO 95% (STANDARD PROCTOR).
 PROOF ROLLING REQUIRED ON ALL SUBGRADES.


CURVE TABLE

CURVE	RADIUS	ARC LENGTH	CHORD LENGTH	CHORD BEARING	DELTA ANGLE	TANGENT
CURVE#1	800.00'	303.63'	301.81'	S86'55'54"E	21'44'45"	153.66'
CURVE#2	75.00'	100.77	93.36'	S59'18'48"E	76'58'57"	59.64'
CURVE#3	1350.00	68.89'	68.88'	N71'35'07"E	02'55'25"	34.45'
CURVE#4	485.50'	120.24'	119.94'	N63'01'42"E	14'11'26"	60.43'
CURVE#5	1014.50	234.52'	234.00'	N62'33'20"E	13'14'42"	117.78'
CURVE#6	1014.50'	224.82'	224.36'	N75'31'36"E	12'41'50"	112.87
	•					

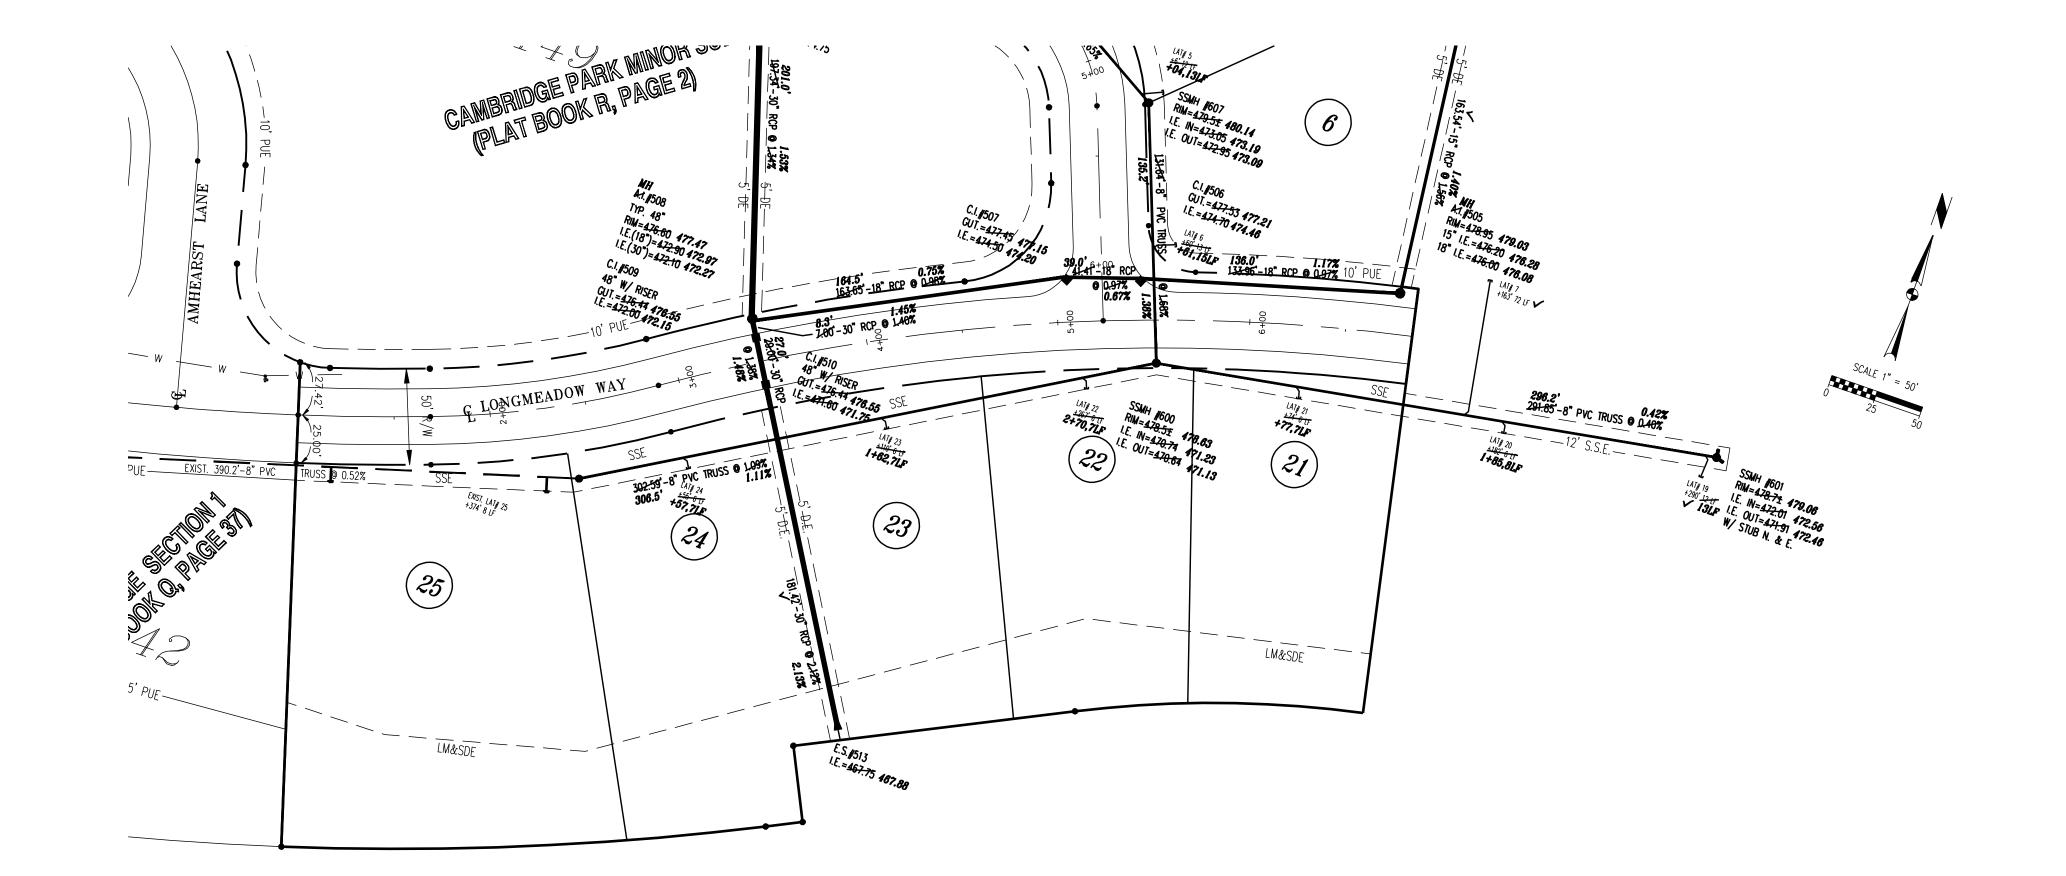

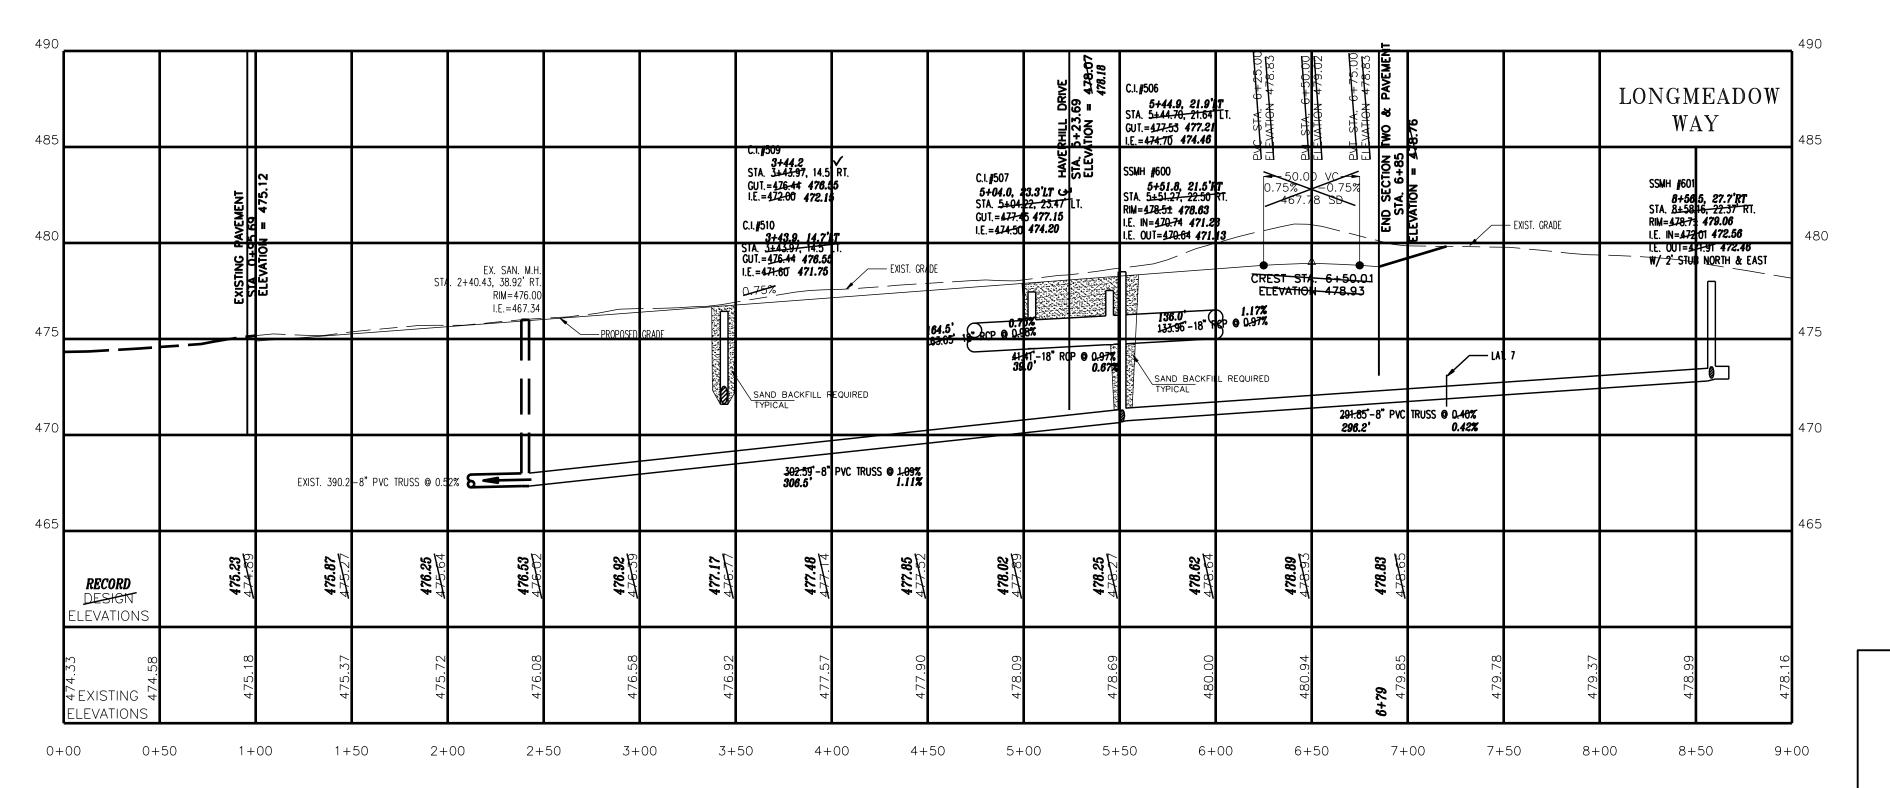

RECORD DRAWING By:______

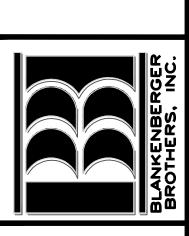

Sheet Number: $\mathrm{RP}-1$

• THE FOLLOWING LOCAL GOVERNMENTAL AGENCY SHALL BE NOTIFIED 24 HOURS PRIOR TO BEGINNING WORK AND ON A DAILY BASIS WHEN PERFORMING THE WORK LISTED BELOW:

STORM SEWERS, STREET SUBGRADE, STREETS
VANDERBURGH COUNTY ENGINEER 812-435-5773

SANITARY SEWERS


EVANSVILLE WATER & SEWER UTILITY OPERATIONS DEPT. 812-421-2130

GENERAL SITE

- WORK COVERS ALL EARTHWORK, SEWERS, PAYING AND OTHER RELATED WORK FOR THE DEVELOPMENT OF CAMBRIDGE SECTION TWO.
- THE CONTRACTOR SHALL COMPLY WITH ALL LOCAL, STATE AND FEDERAL CODES, ORDINANCES, RULES, REQUIATIONS, ORDERS AND OTHER LEGAL REQUIREMENTS OF MUNICIPAL AUTHORITIES WHICH BEAR ON THE PERFORMANCE OF THE WORK.
- ALL FIELD ENGINEERING SHALL BE SUPPLIED BY THE OWNER.
- ALL BUILDING PAD FILL MATERIAL SHALL BE COMPACTED TO 95% (STANDARD PROCTOR).
 PROOF ROLLING REQUIRED ON ALL SUBGRADES.

CURVE TABLE

CURVE	RADIUS	ARC LENGTH	CHORD LENGTH	CHORD BEARING	DELTA ANGLE	TANGENT
CURVE#1	800.00'	303.63'	301.81'	S86'55'54"E	21'44'45"	153.66'
CURVE#2	75.00'	100.77	93.36'	S59'18'48"E		59.64'
CURVE#3	1350.00	68.89'	68.88	N71°35'07"E	02'55'25"	34.45'
CURVE#4	485.50'	120.24	119.94'	N63'01'42"E	14'11'26"	60.43'
CURVE#5	1014.50	234.52'	234.00'	N62'33'20"E	13'14'42"	117.78
CURVE#6	1014.50	224.82'	224.36'	N75'31'36"E	12'41'50"	112.87

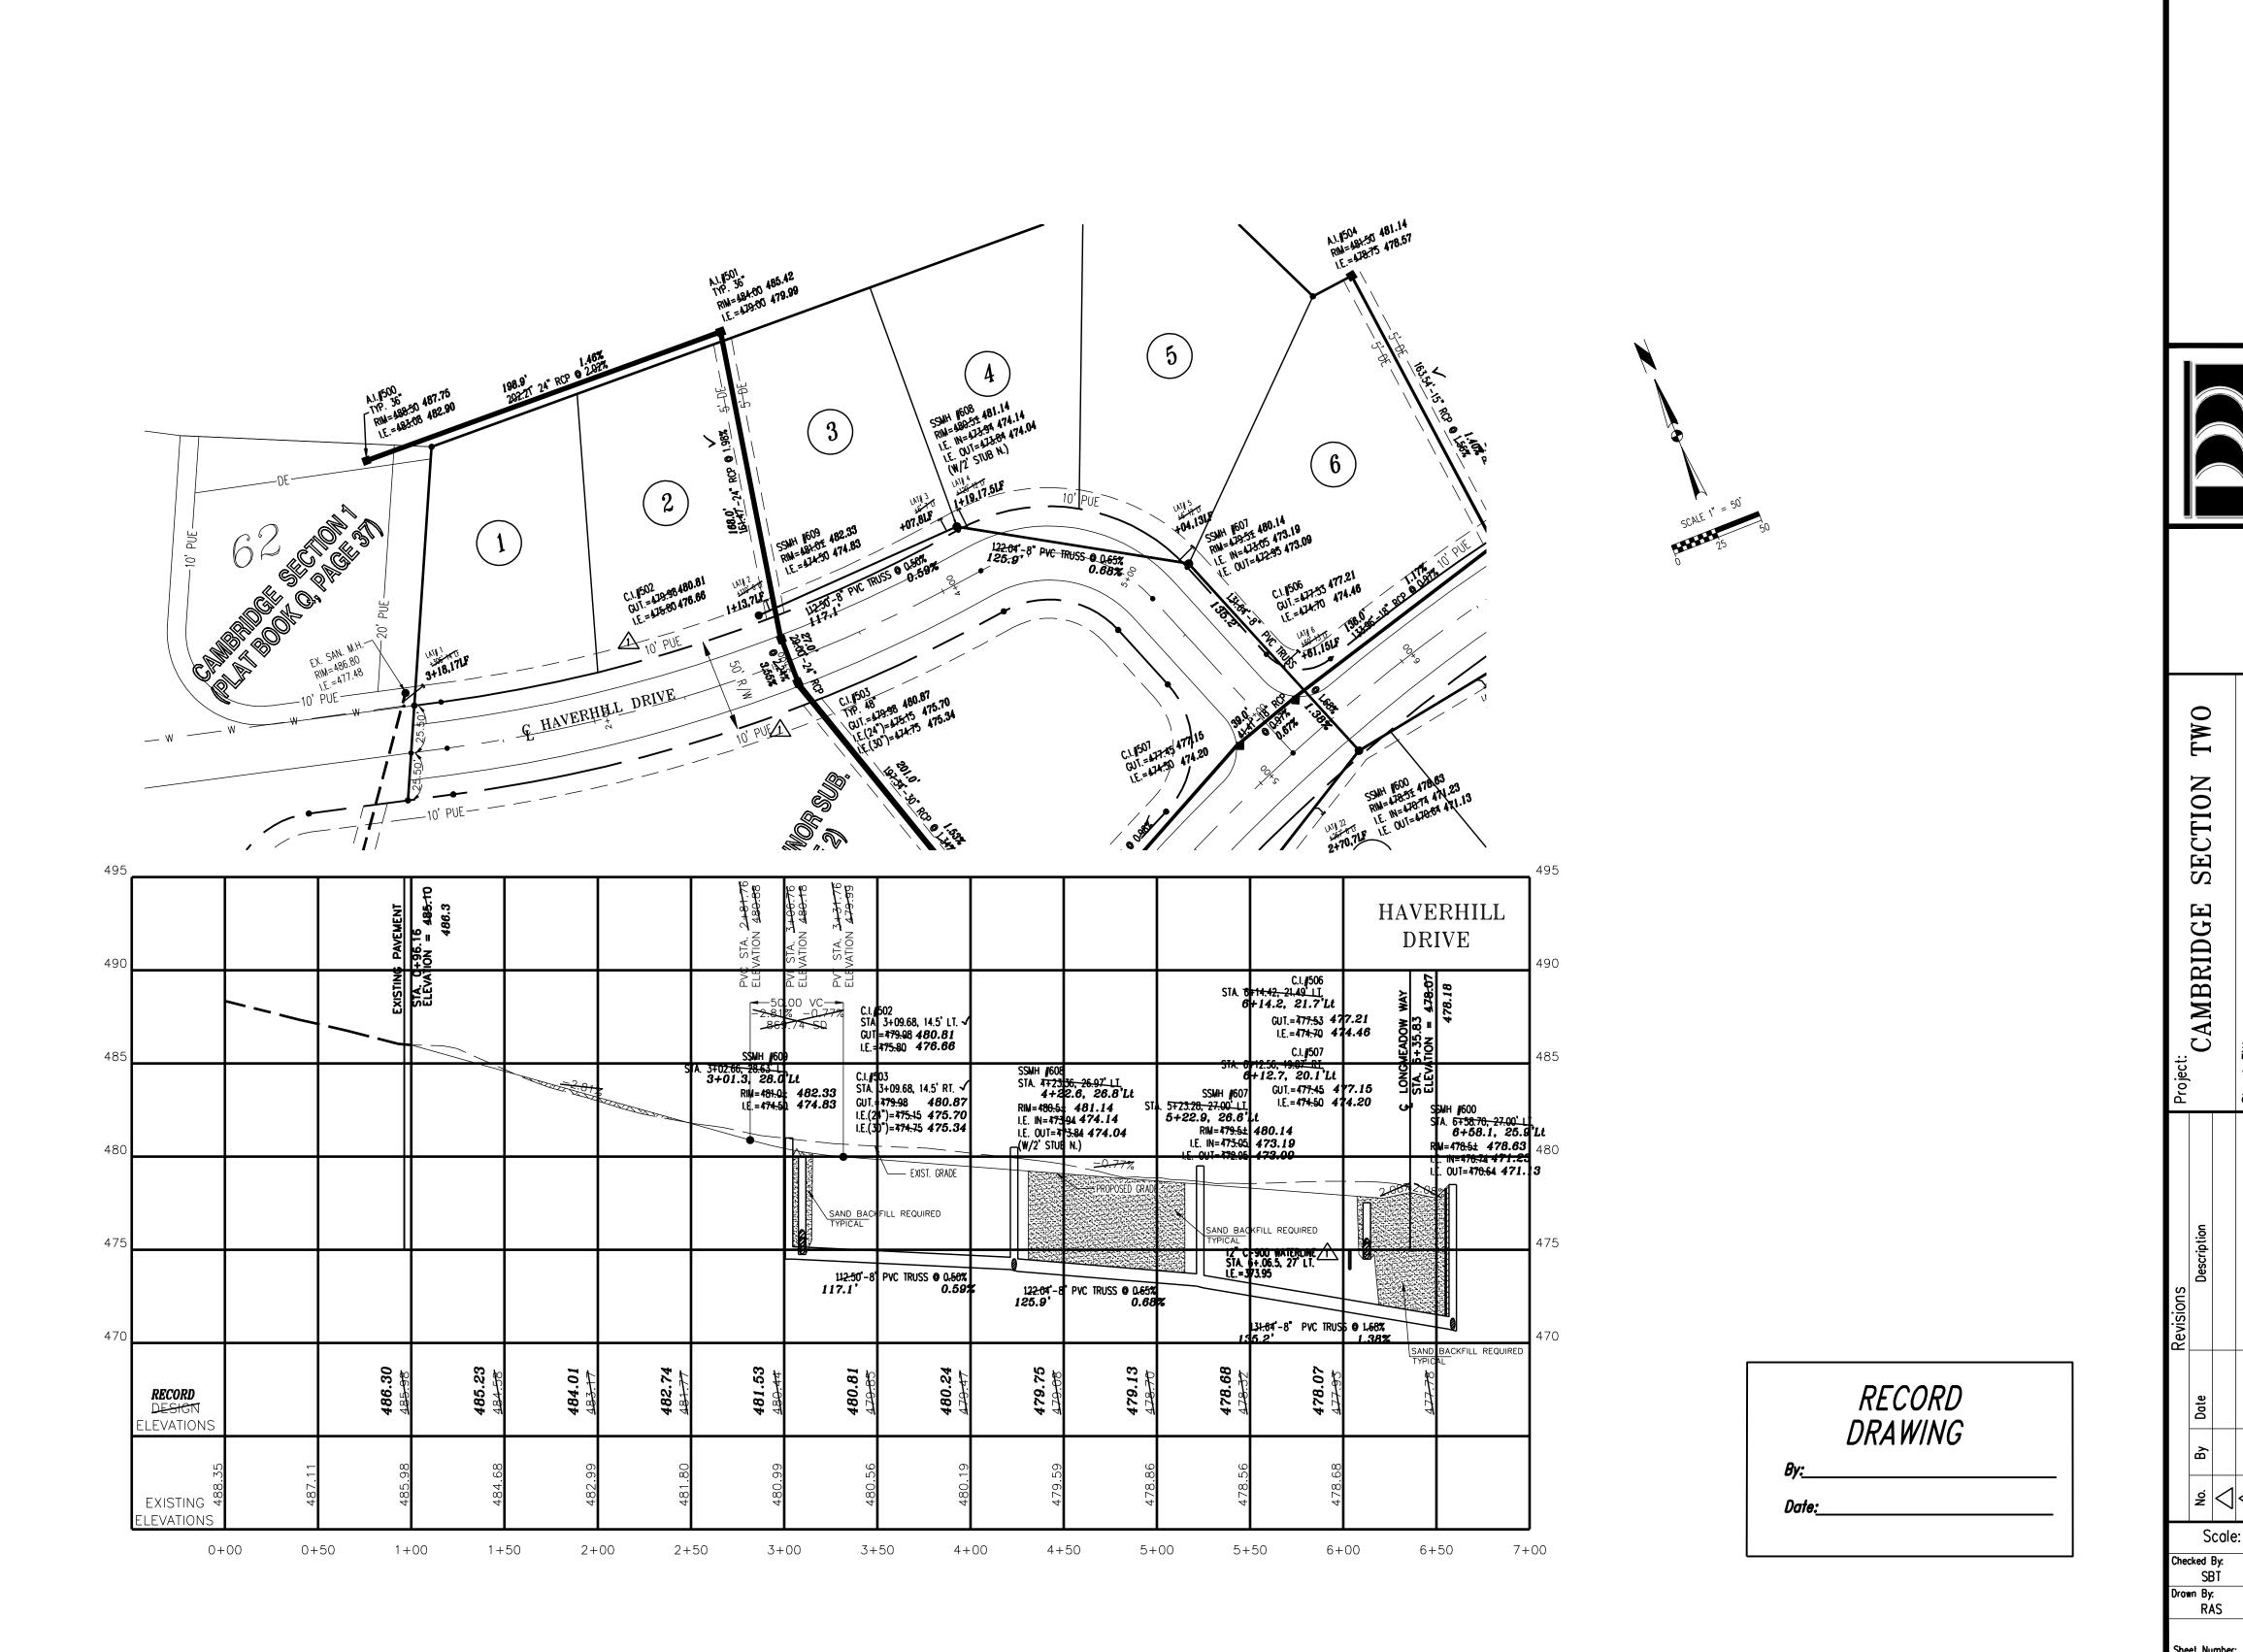



Revisions
Revisions
Revisions
Revisions
Revisions
CAMBRIDGE SECTION TWO
CAMBRIDGE SECTION TWO
Sheet Title:


Sheet Title:

HAVERHILL DRIVE

 ${
m RP-2}$

Date: 12-18-08

STORM STRUCTURE TABLE STRUCTURE GRATE NUMBER STRUCTURE TYPE CASTING 500 A.I.-TYPE "36" E.J. 6610 OPEN 501 A.L-TYPF "36" F.J. 6610 OPEN 502 C.I.-TYPE "J" E.J. 7030 M4 503 C.I.-TYPE "48" W/ RISER E.J. 7030 M4 504 A.I.-TYPE "E" E.J. 6610 OPEN Sould Lid 505 A.I.-TYPE "E" E.J. 6610 OPEN 506 C.I.-TYPE "J" E.J. 7030 М3 507 C.I.-TYPE "J" E.J. 7030 М3 508 A.I.-TYPE "48" SOLID LID 509 C.I.-TYPE "48" W/ RISER E.J. 7030 M4 510 C.I.-TYPE "48" W/ RISER E.J. 7030 M4 513 30" CONC. END SECTION

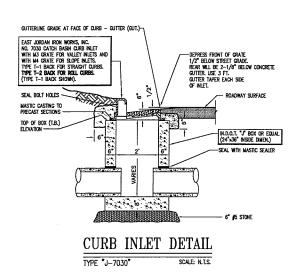


FOR DITCH FLOWLINES OF 0%-2% USE

ELEV VARIES (SEE PLAN)

"VERDYOL ERO-MAT STANDARD" EROSION CONTROL BLANKET OR

TYP. DITCH SECTION
DITCH SLOPE > 0.80% N.T.S.

APPROVED EQUAL.

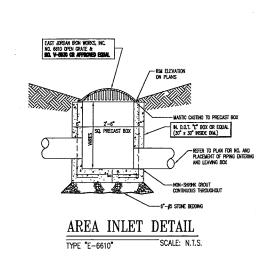

GENERAL NOTES

GENERAL SITE


- WORK COVERS ALL EARTHWORK, SEWERS, PAVING AND OTHER RELATED WORK FOR THE DEVELOPMENT OF "CAMBRIDGE SECTION TWO."
- THE CONTRACTOR SHALL COMPLY WITH ALL LOCAL, STATE AND FEDERAL CODES, ORDINANCES, RULES, REGULATIONS, ORDERS AND OTHER LEGAL REQUIREMENTS OF MUNICIPAL AUTHORITIES WHICH BEAR ON THE PERFORMANCE OF THE WORK.
- ALL FIELD ENGINEERING SHALL BE SUPPLIED BY THE OWNER.
- CONTRACTOR SHALL NOTIFY COUNTY ENGINEER BEFORE PLACING ANY STRUCTURE OR LINE UNDER PROPOSED ROADWAYS 435-5773

EXCAVATING

- ROADWAY SUBGRADE COMPACTION TESTS SHALL BE PERFORMED AT CONTRACTORS EXPENSE.
- SUFFICIENT SOIL SAMPLES ARE TO BE TAKEN BY THE CONTRACTOR FROM THE ROADWAY SUBGRADE AFTER THE TOPSOIL IS REMOVED OR FROM BORROW AREAS IN ORDER TO OBTAIN ACCURATE PROCTOR VALUES FOR SUBSEQUENT SUBGRADE DENSITY TESTING.
- SUBGRADE IS TO BE COMPACTED IN ACCORDANCE WITH VANDERBURGH COUNTY ROAD STANDARDS.
- SUBGRADE DENSITY IS TO BE TESTED AT A MINIMUM OF ONE TEST PER SECTION OF ROADWAY CONNECTED BY AN INTERSECTION. OTHERS MAY BE REQUESTED AT THE DISCRETION OF THE INSPECTOR OR ENGINEER.
- · DRAWINGS DO NOT REPRESENT A BALANCE BETWEEN BORROW AND FILL MATERIAL.
- TOP SOIL WILL BE SALVAGED & PLACED IN ALL AREAS OF THE SITE EXCEPT FOR A 40' STRIP BEHIND THE 20' BUILDING SETBACK LINE, AREA WHERE STREETS WILL BE CONSTRUCTED, AND AREAS BELOW THE NORMAL POOL OF THE RETENTION BASIN.

STORM SEWERS


- ALL STORM SEWERS SHALL BE CONSTRUCTED IN ACCORDANCE WITH VANDERBURGH COUNTY STANDARDS.
- ALL LENGTHS OF STORM SEWER PIPE TERMINATING OR BEGINNING WITH END SECTIONS REFER TO THE DISTANCE FROM THE CENTERLINE OF STRUCTURE TO THE FLOMLINE OF THE END SECTION.

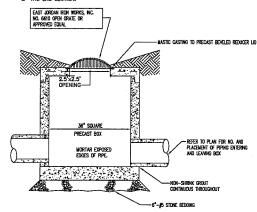

MANHOLE-TYPE "48" SCALE: N.T.S.

EAST JORDAN IRON WORKS, INC. NO. 8810 OPEN GRATE OR APPROVED EQUAL

2.5'×2.5'

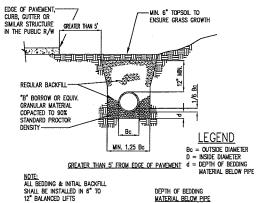

astic casting to precast beveled reducer Lid


NOTE: ALL BEDDING & INITIAL BACKFILL SHALL BE INSTALLED IN 6" TO 12" BALANCED LIFTS

A MINIMUM 9" OF CLEARANCE SHALL BE PROVIDED ON EACH SIDE OF THE INSTALLED PIPE 27" & SMALLER 30" TO 60" 66" & LARGER

PIPE BEDDING DETAIL

RCP - CLASS III OR IV SCALE: N.T.S.

MANHOLE-TYPE "36" SCALE: N.T.S.

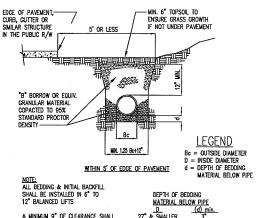

NOTE: ALL BEDDING & INITIAL BACKFILL SHALL BE INSTALLED IN 6" TO 12" BALANCED LIFTS

A MINIMUM 9" OF CLEARANCE SHALL BE PROVIDED ON EACH SIDE OF THE INSTALLED PIPE 27" & SMALLER 30" TO 60" 66" & LARGER

SCALE: N.T.S.

PIPE BEDDING DETAIL

RCP - CLASS III OR IV

O In 10335 Hedden Rd. Suite 2 Evansville, Indiana 47725 (812) 868-0877 SITECON TW0SECTION DETAILS STORM CAMBRIDGE
Sheet Title:

Wittlen dimensions on these drawings shall have procedures scode dimensions. Conflorer shall writing rail be responsible to conditions and conditions on the pbs and STECON. The minust be notified of any varidations from the dimensions conditions shown by these drawings.

Scale: AS NOTED esigned By: Job Number: 543-08-8 | Joh Number: 543-08-8 | Johns By: Date: 07-21-08

DETAIL-STORM DE-3

STD. REINF. FOR CIRCULAR—
CLS. III B. WALL R.C.C.P.

SIDE VIEW

END VIEW

CONCRETE END SECTION DETAIL

- NOTE: END CONECTION TO FIT PIPE USED

TOP VIEW

SCALE: N.T.S.

× ^ PIPE DIA.

-3500 PSI CONC. FOOTING